



FRONT ELEVATION
 SCALE: 0' 1" = 8' 0" (1:100)

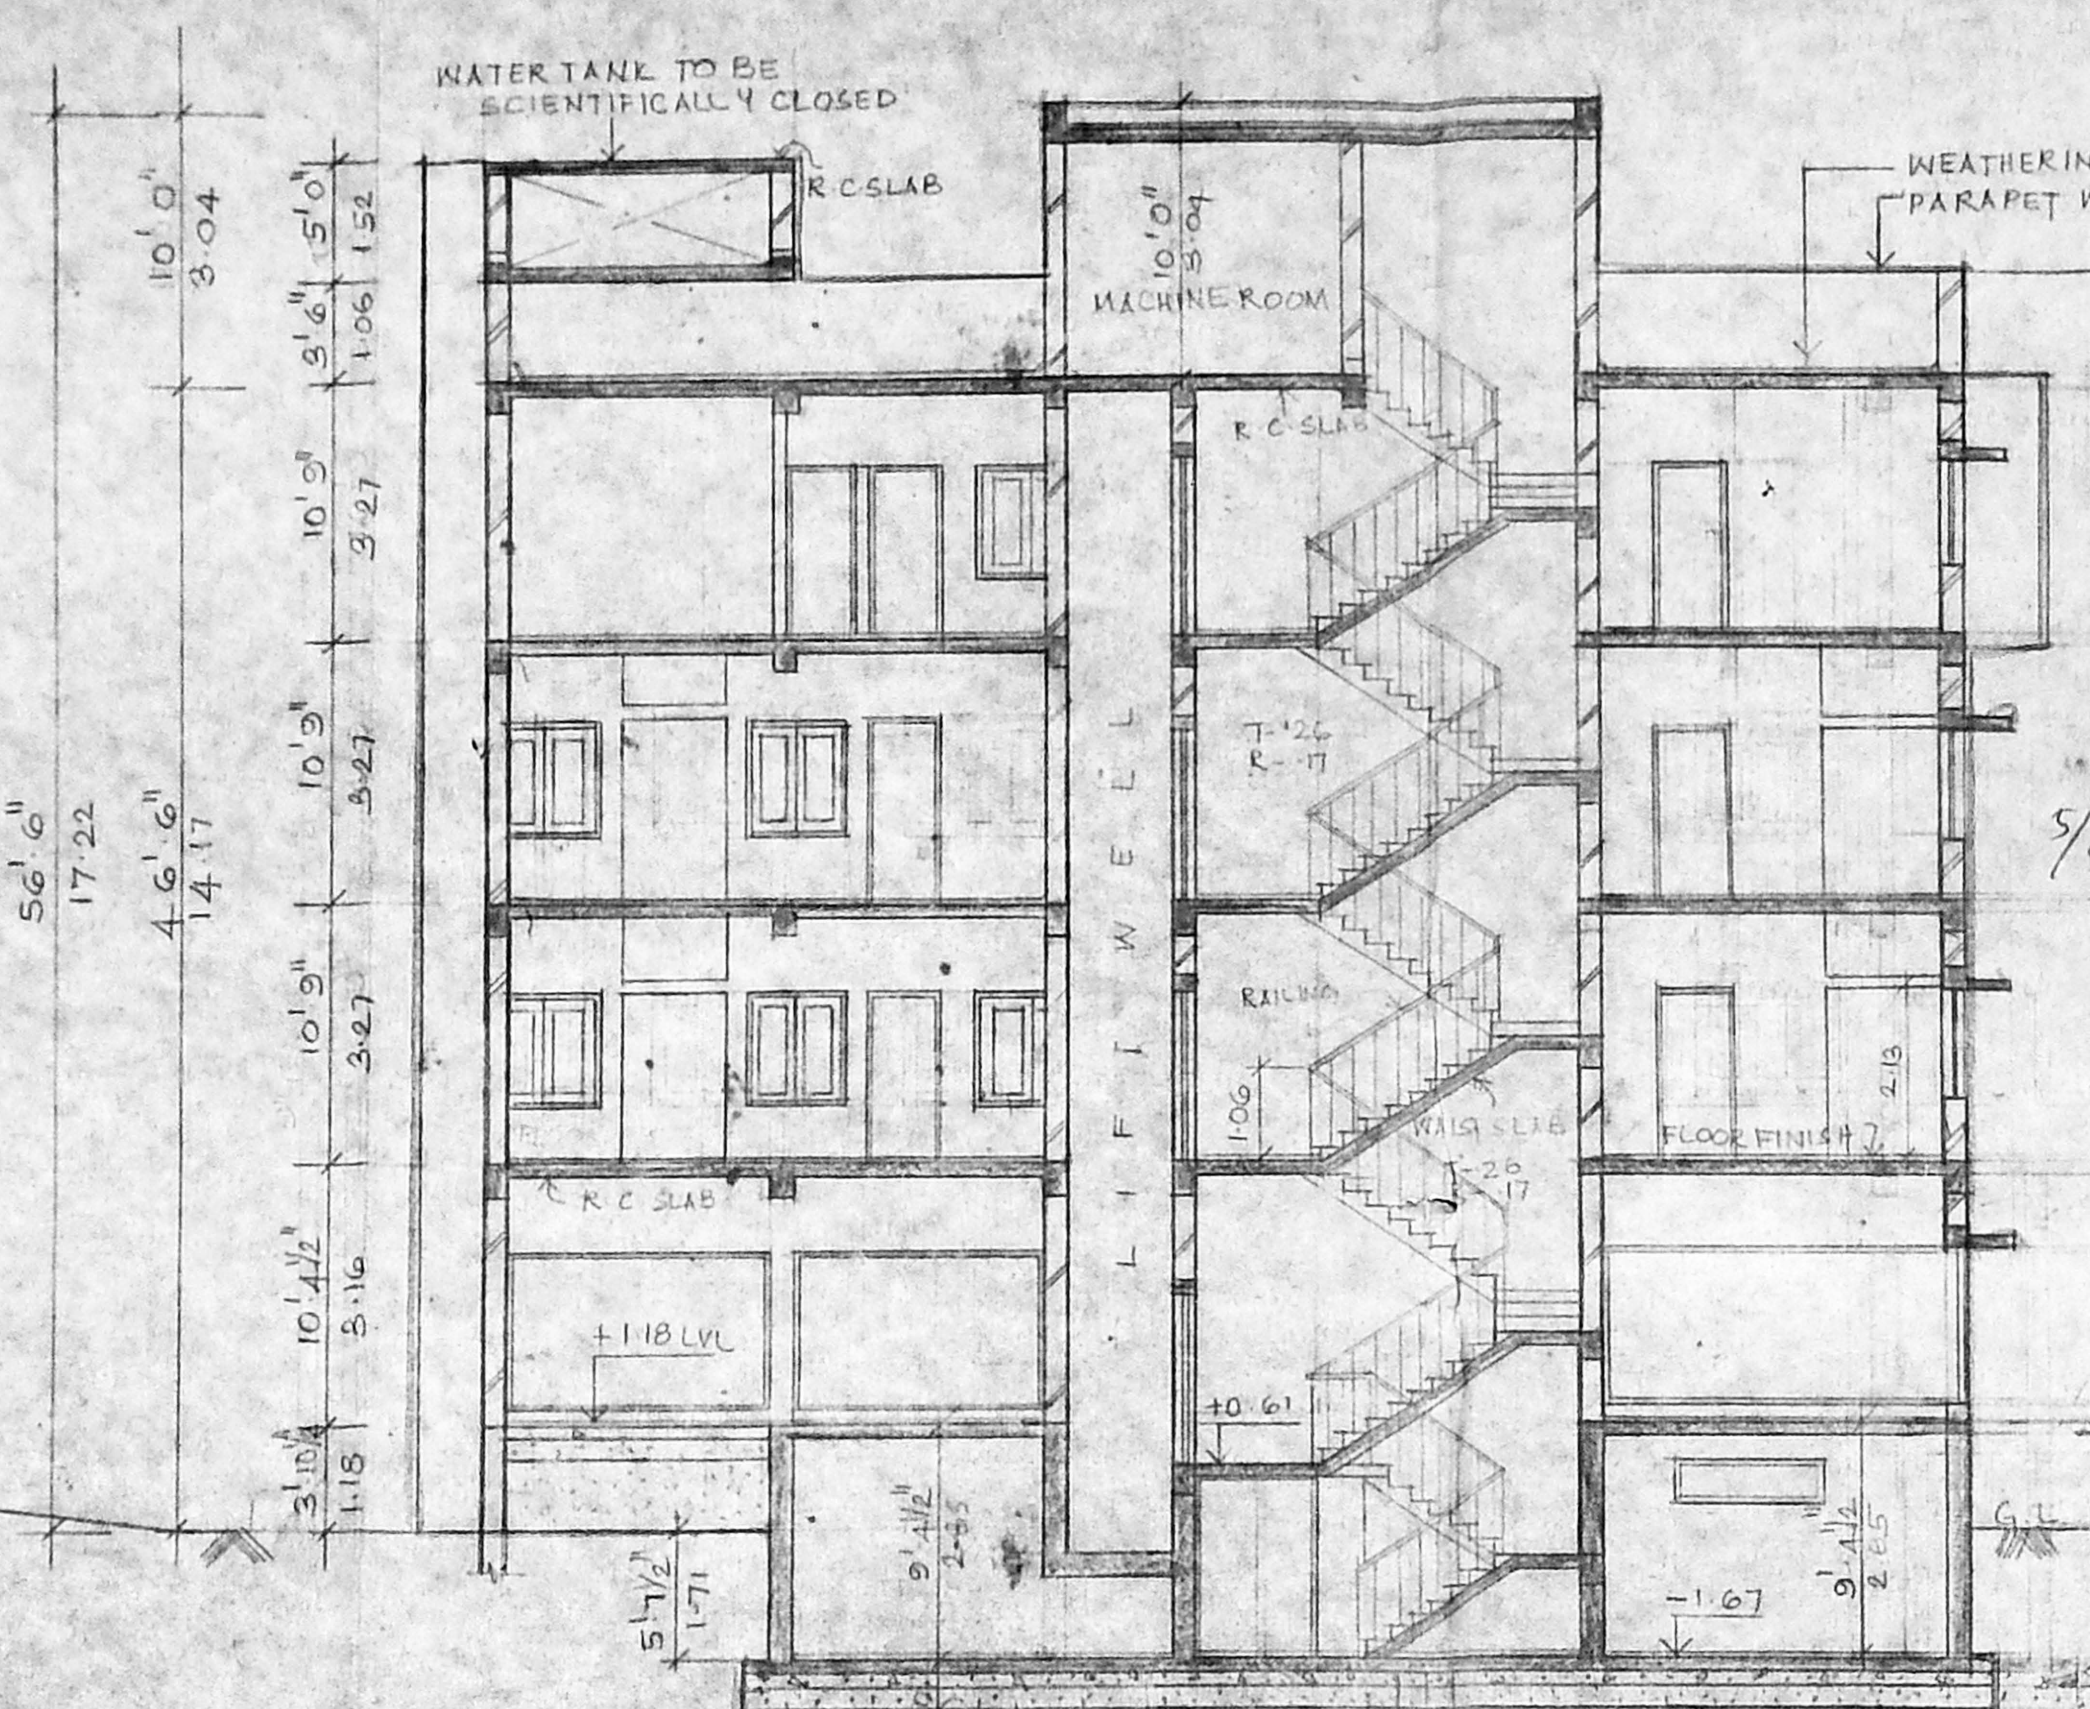

SECTION-AA
 SCALE: 0' 1" = 8' 0" (1:100)


B/1999/SBS/95
 APPROVED
 SUBJECT TO THE CONDITIONS IN THIS OFFICE LETTER
 No. 71/12220/Date: 11.9.95
 FOR MEMBER SECRETARY
 MADRAS METROPOLITAN
 DEVELOPMENT AUTHORITY
 MADRAS-600008

KEY PLAN
 NOT TO SCALE

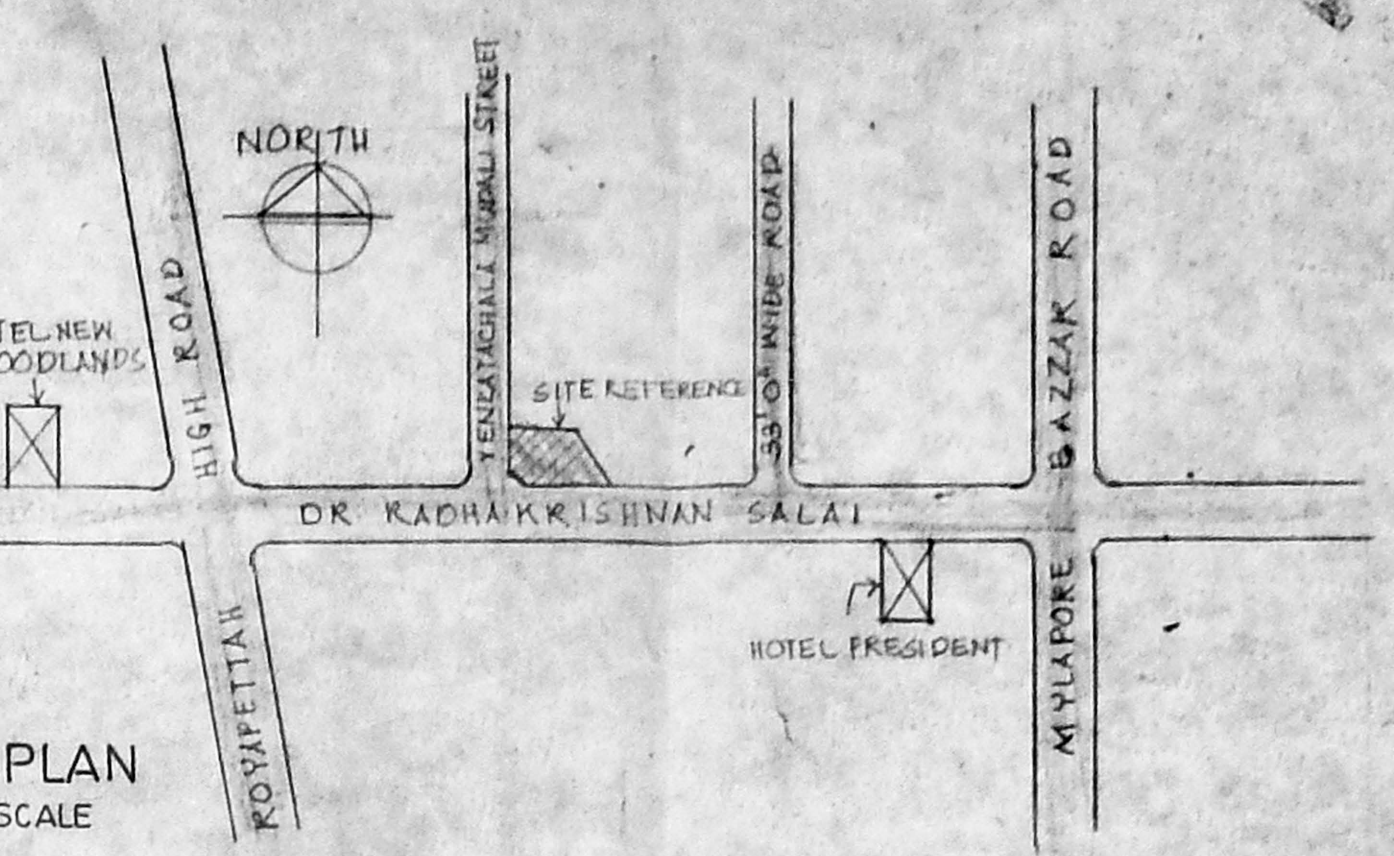


schedule of joinery


SNOW WIDTH	HEIGHT	DESCRIPTION
MD 23.84	2.18	MAIN DOOR
MD1 1.52	2.18	-DO-
MD2 1.06	2.18	-DO-
D 0.31	2.18	DOOR
DZ 0.76	2.13	-DO-
W 1.82	1.37	WINDOW
W1 1.52	1.37	-DO-
W2 1.21	1.37	-DO-
V 1.82	0.45	VENTILATOR
V1 1.21	0.45	-DO-
V2 0.31	0.45	-DO-
SW 4.84	1.38	SHOW WINDOW
SW1 4.81	1.38	-DO-
SW2 3.35	1.38	-DO-
SW3 3.20	1.38	-DO-
SW4 5.02	1.38	-DO-

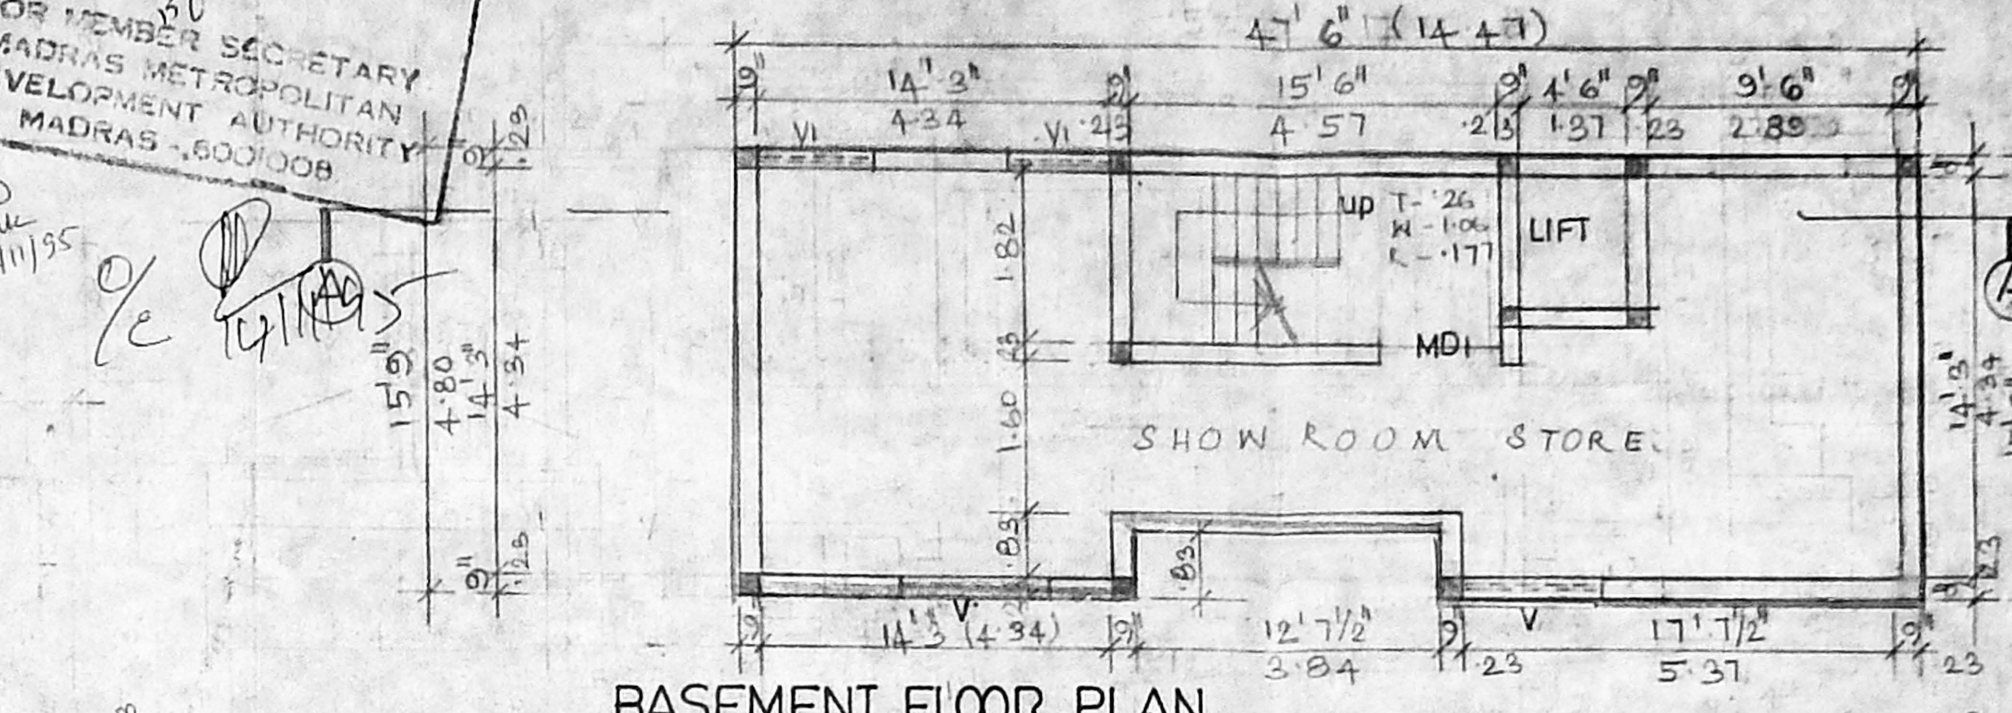


BASEMENT FLOOR PLAN

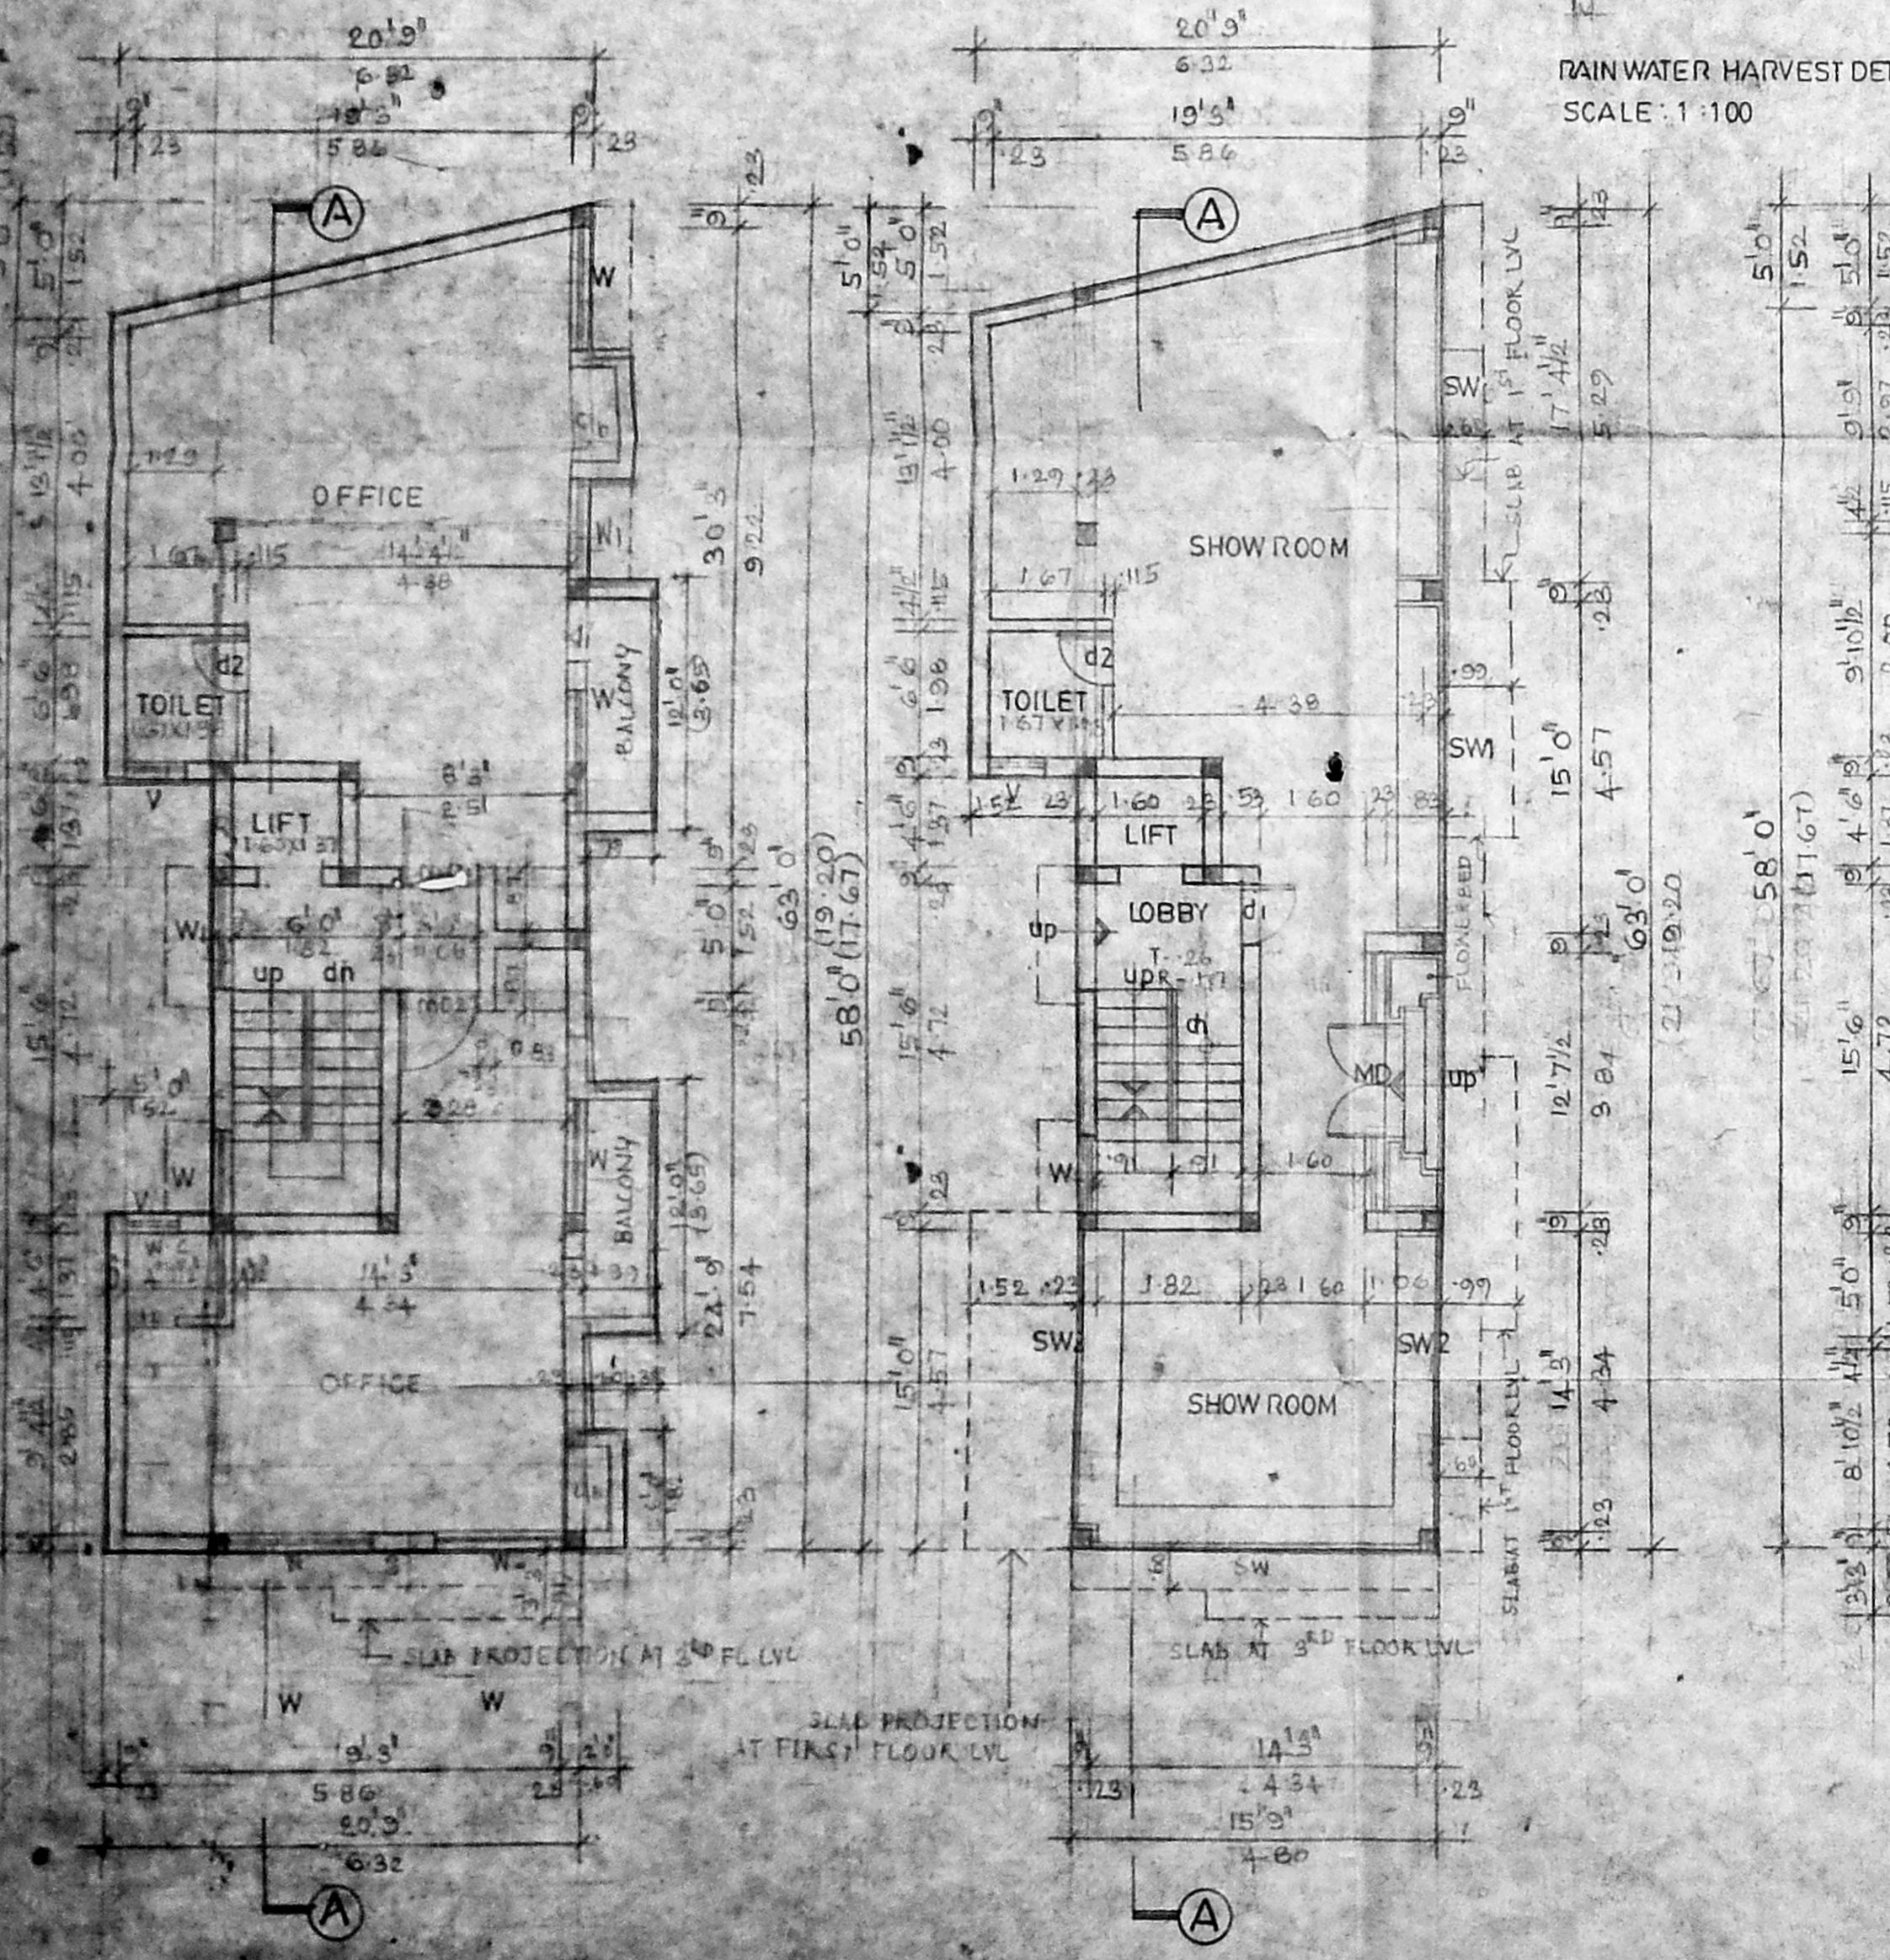


GROUND FLOOR PLAN
 SCALE: 0' 1" = 8' 0" (1:100)

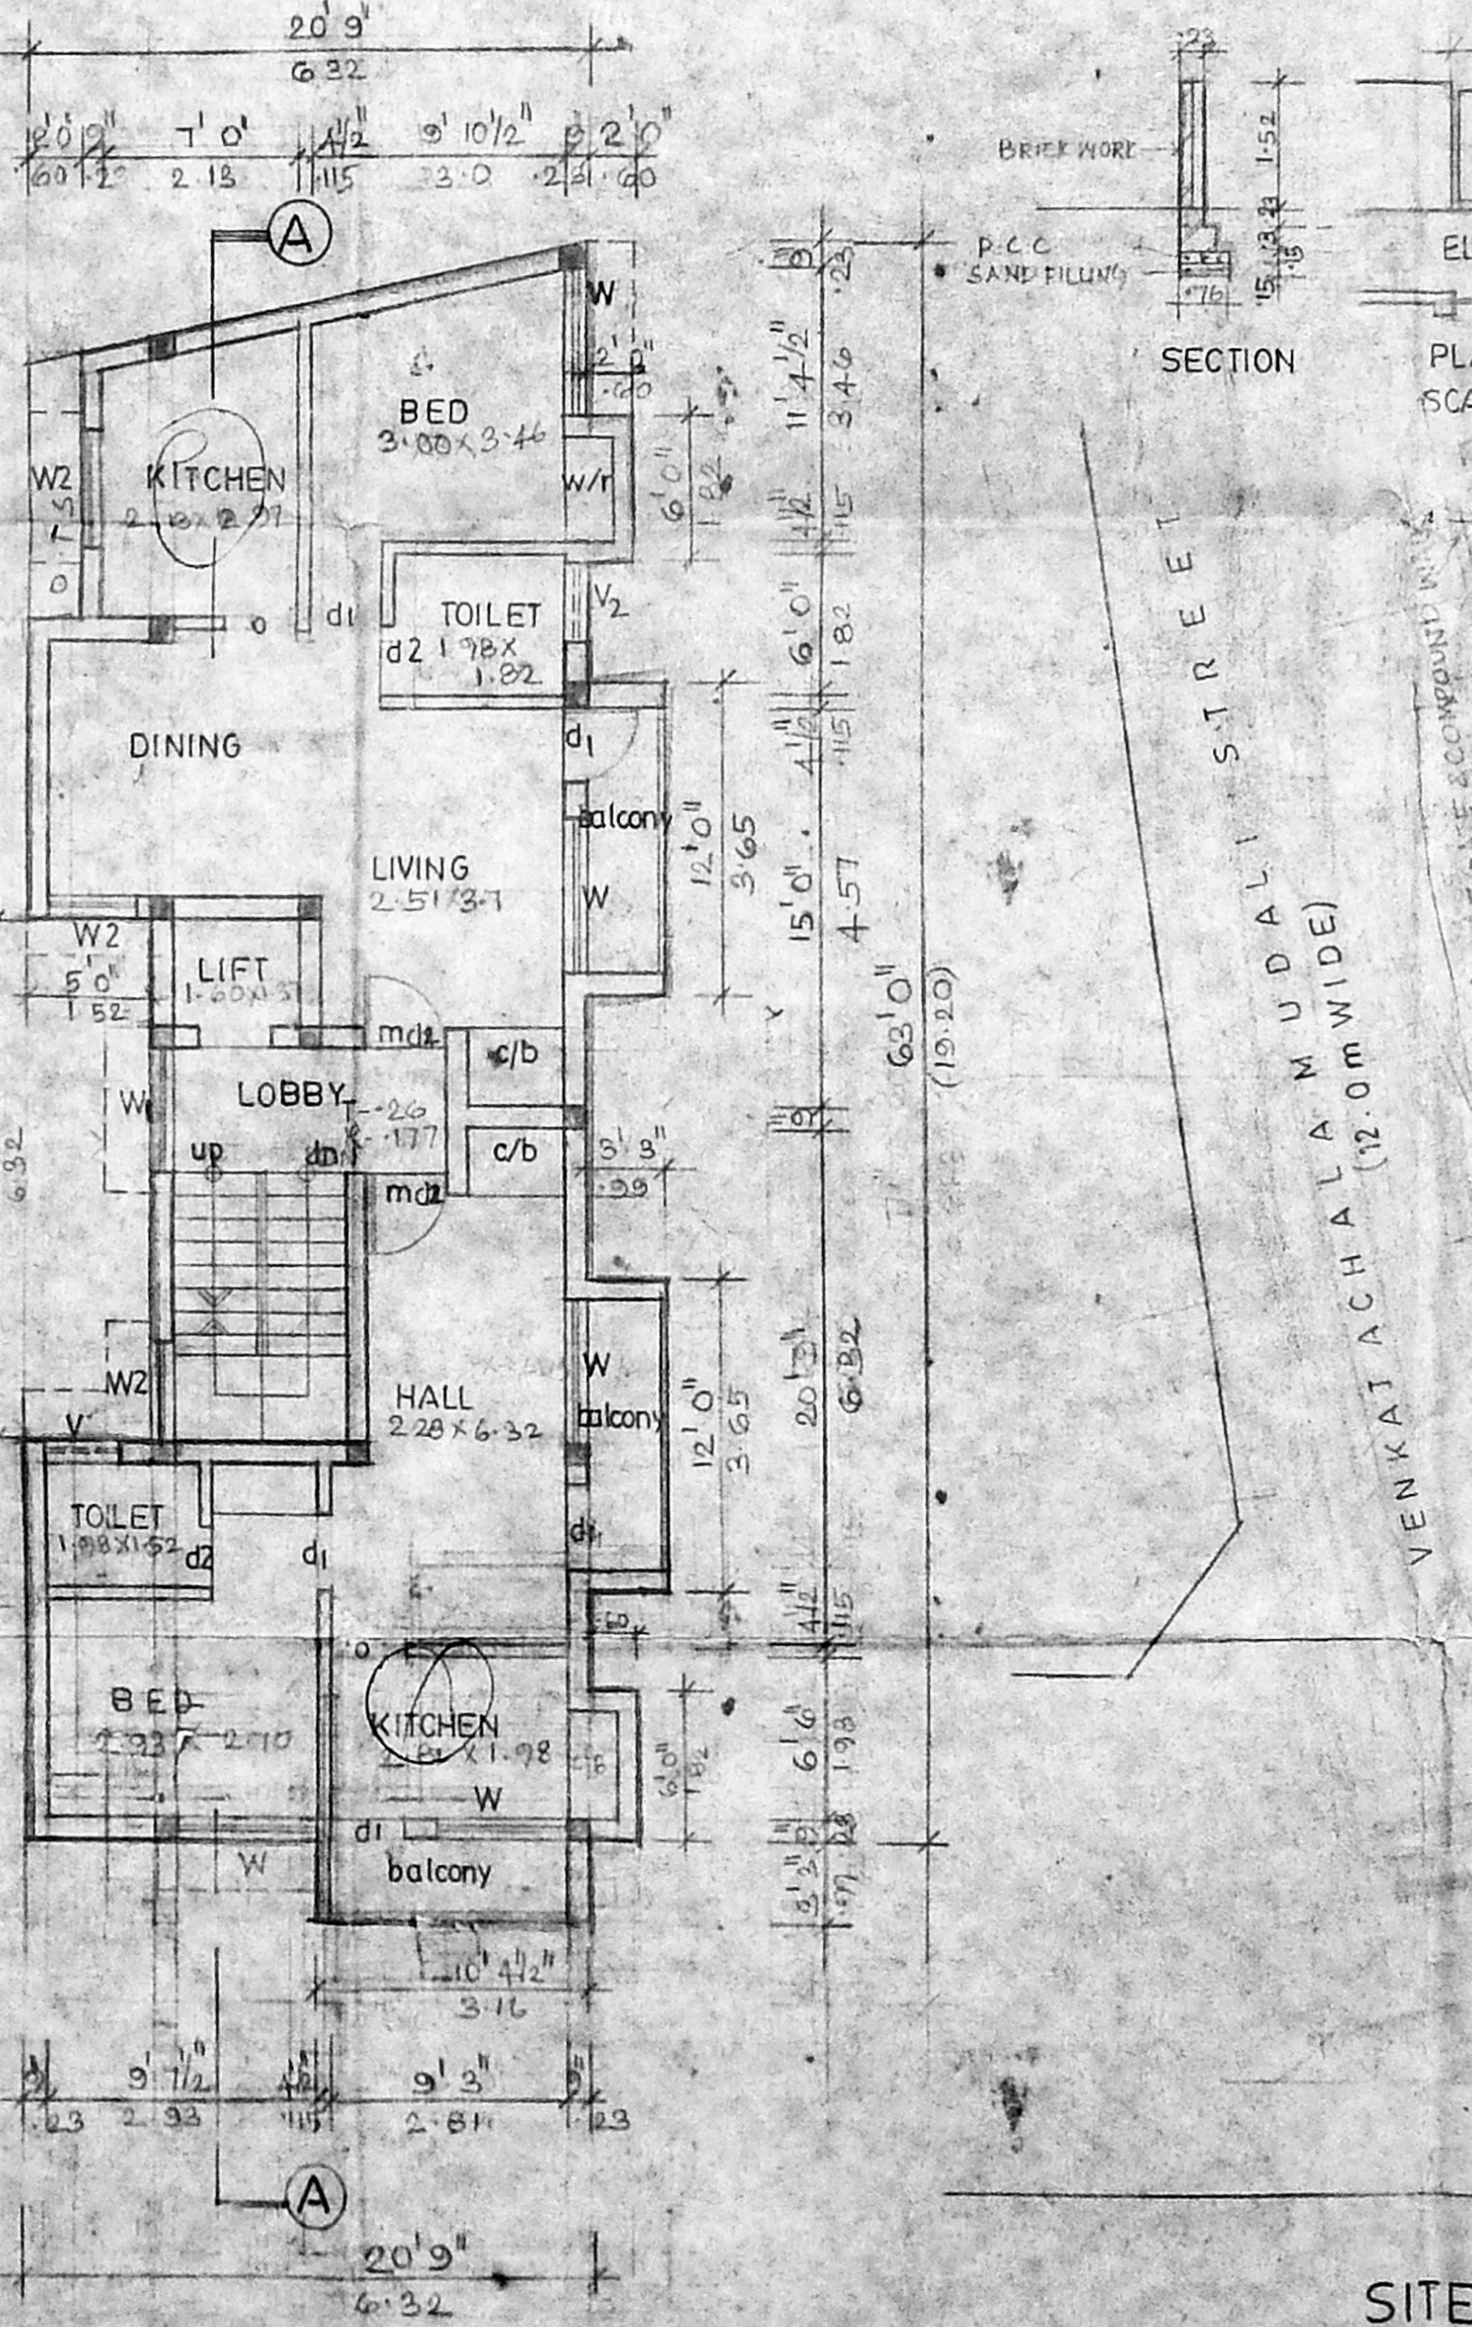

THIRD FLOOR PLAN
 SCALE: 0' 1" = 8' 0" (1:100)

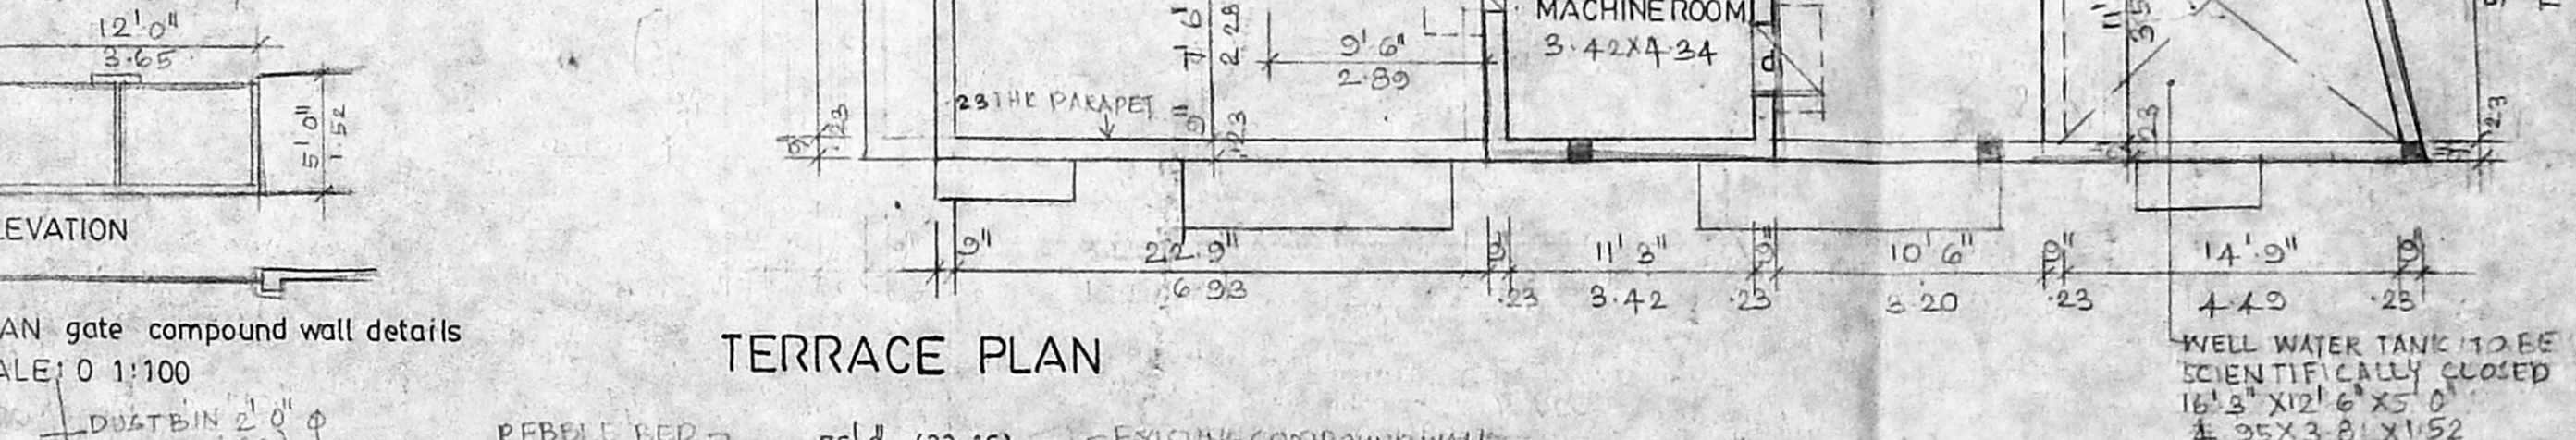

TERRACE PLAN

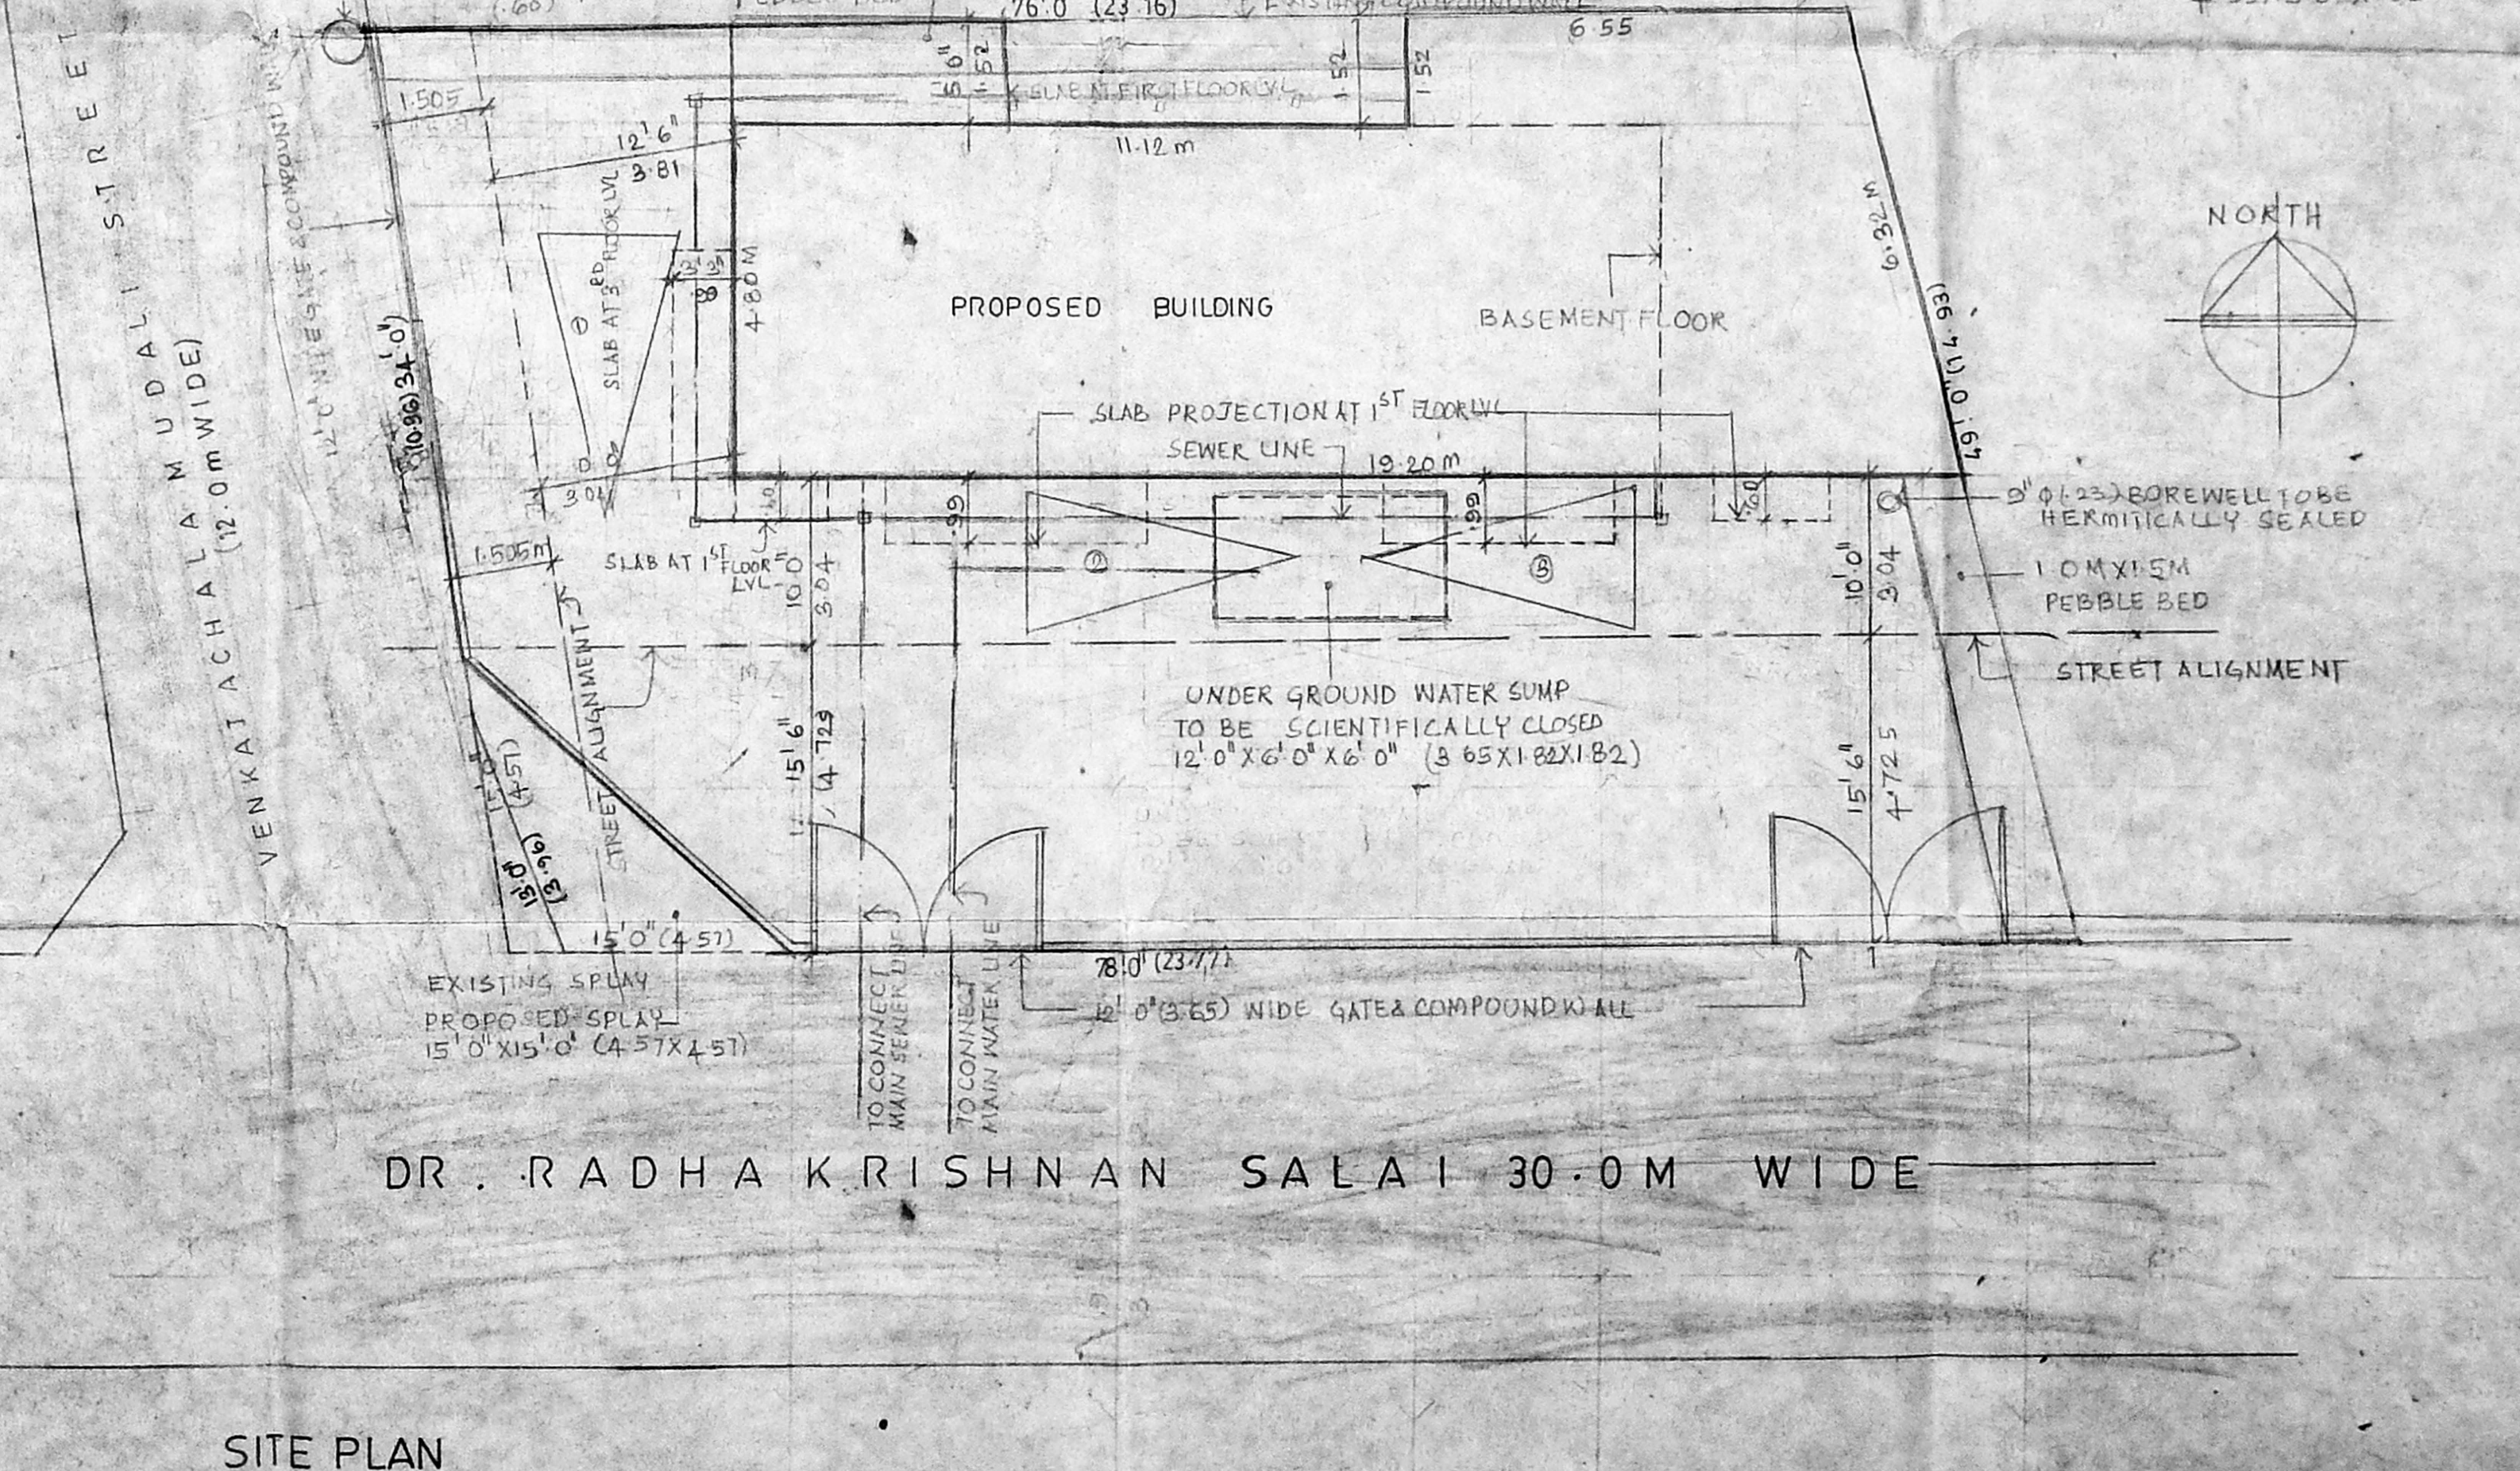

SITE PLAN
 SCALE: 0' 1" = 8' 0" (1:100)

specifications

FOUNDATION	RCC RAFT & RCC COLUMN FOOTING OVER SAND FILLING & P.C.C. 1:4:8
SUPERSTRUCTURE	R.C.C. FRAME WORK WITH BRICK MORTAR IN C.M. 1:6
R.C.C. WORK	ROOFS, LABS, LINTERS, BEAMS & SOLIHIDES IN R.C.C. 1:2:4 WITH SUITABLE REINFORCEMENT
FLOORING	MOSAIC FLOORING
PLASTERING	PLASTERING IN C.M. 1:6
WEATHERING COURSE	BRICK JELLY LIME CONCRETE LAID IN SLOPE WITH CRUDE OIL & FINISHED WITH TERRAZZO TILES
NOTE:	BORE WELL TO BE HERMETICALLY SEALED & SUMP & G+1 TO BE SCIENTIFICALLY CLOSED TO BE SCIENTIFICALLY CLOSED

COLOUR CODE REFERENCE

PROPOSED WORK	---
EXISTING ROAD	---
BOUNDARY	---
WATER LINE	---
SEWER LINE	---

SIGNATURE OF OWNER
[Signature]

SIGNATURE OF ARCHITECT
[Signature]

PROPOSED SHOW ROOM / RESIDENTIAL BUILDING AT DOOR NO. 96, BLOCK NO. 23, R.S. NO. 107, DR. RADHA KRISHNAN SALAI, MYLAPORE, MADRAS.
 REVISED DRAWING
 FLOOR PLANS, ELEVATION, SECTION JOB NO. DRGNO
 SITE PLAN & KEY PLAN etc.
 SCALE: 0' 1" = 8' 0" DATE: 13.5.95 DRAWN: J.V.

ARCHITECT
SELVARAJAN & ASSOCIATES
 NO. 1, SARANGAPANI STREET, T. NAGAR, MS-17.